



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T-001

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RMF ENGINEERING, INC.
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SUITE G
CHARLESTON, SC 29492
P: 843-971-9639 F: 843-971-9641

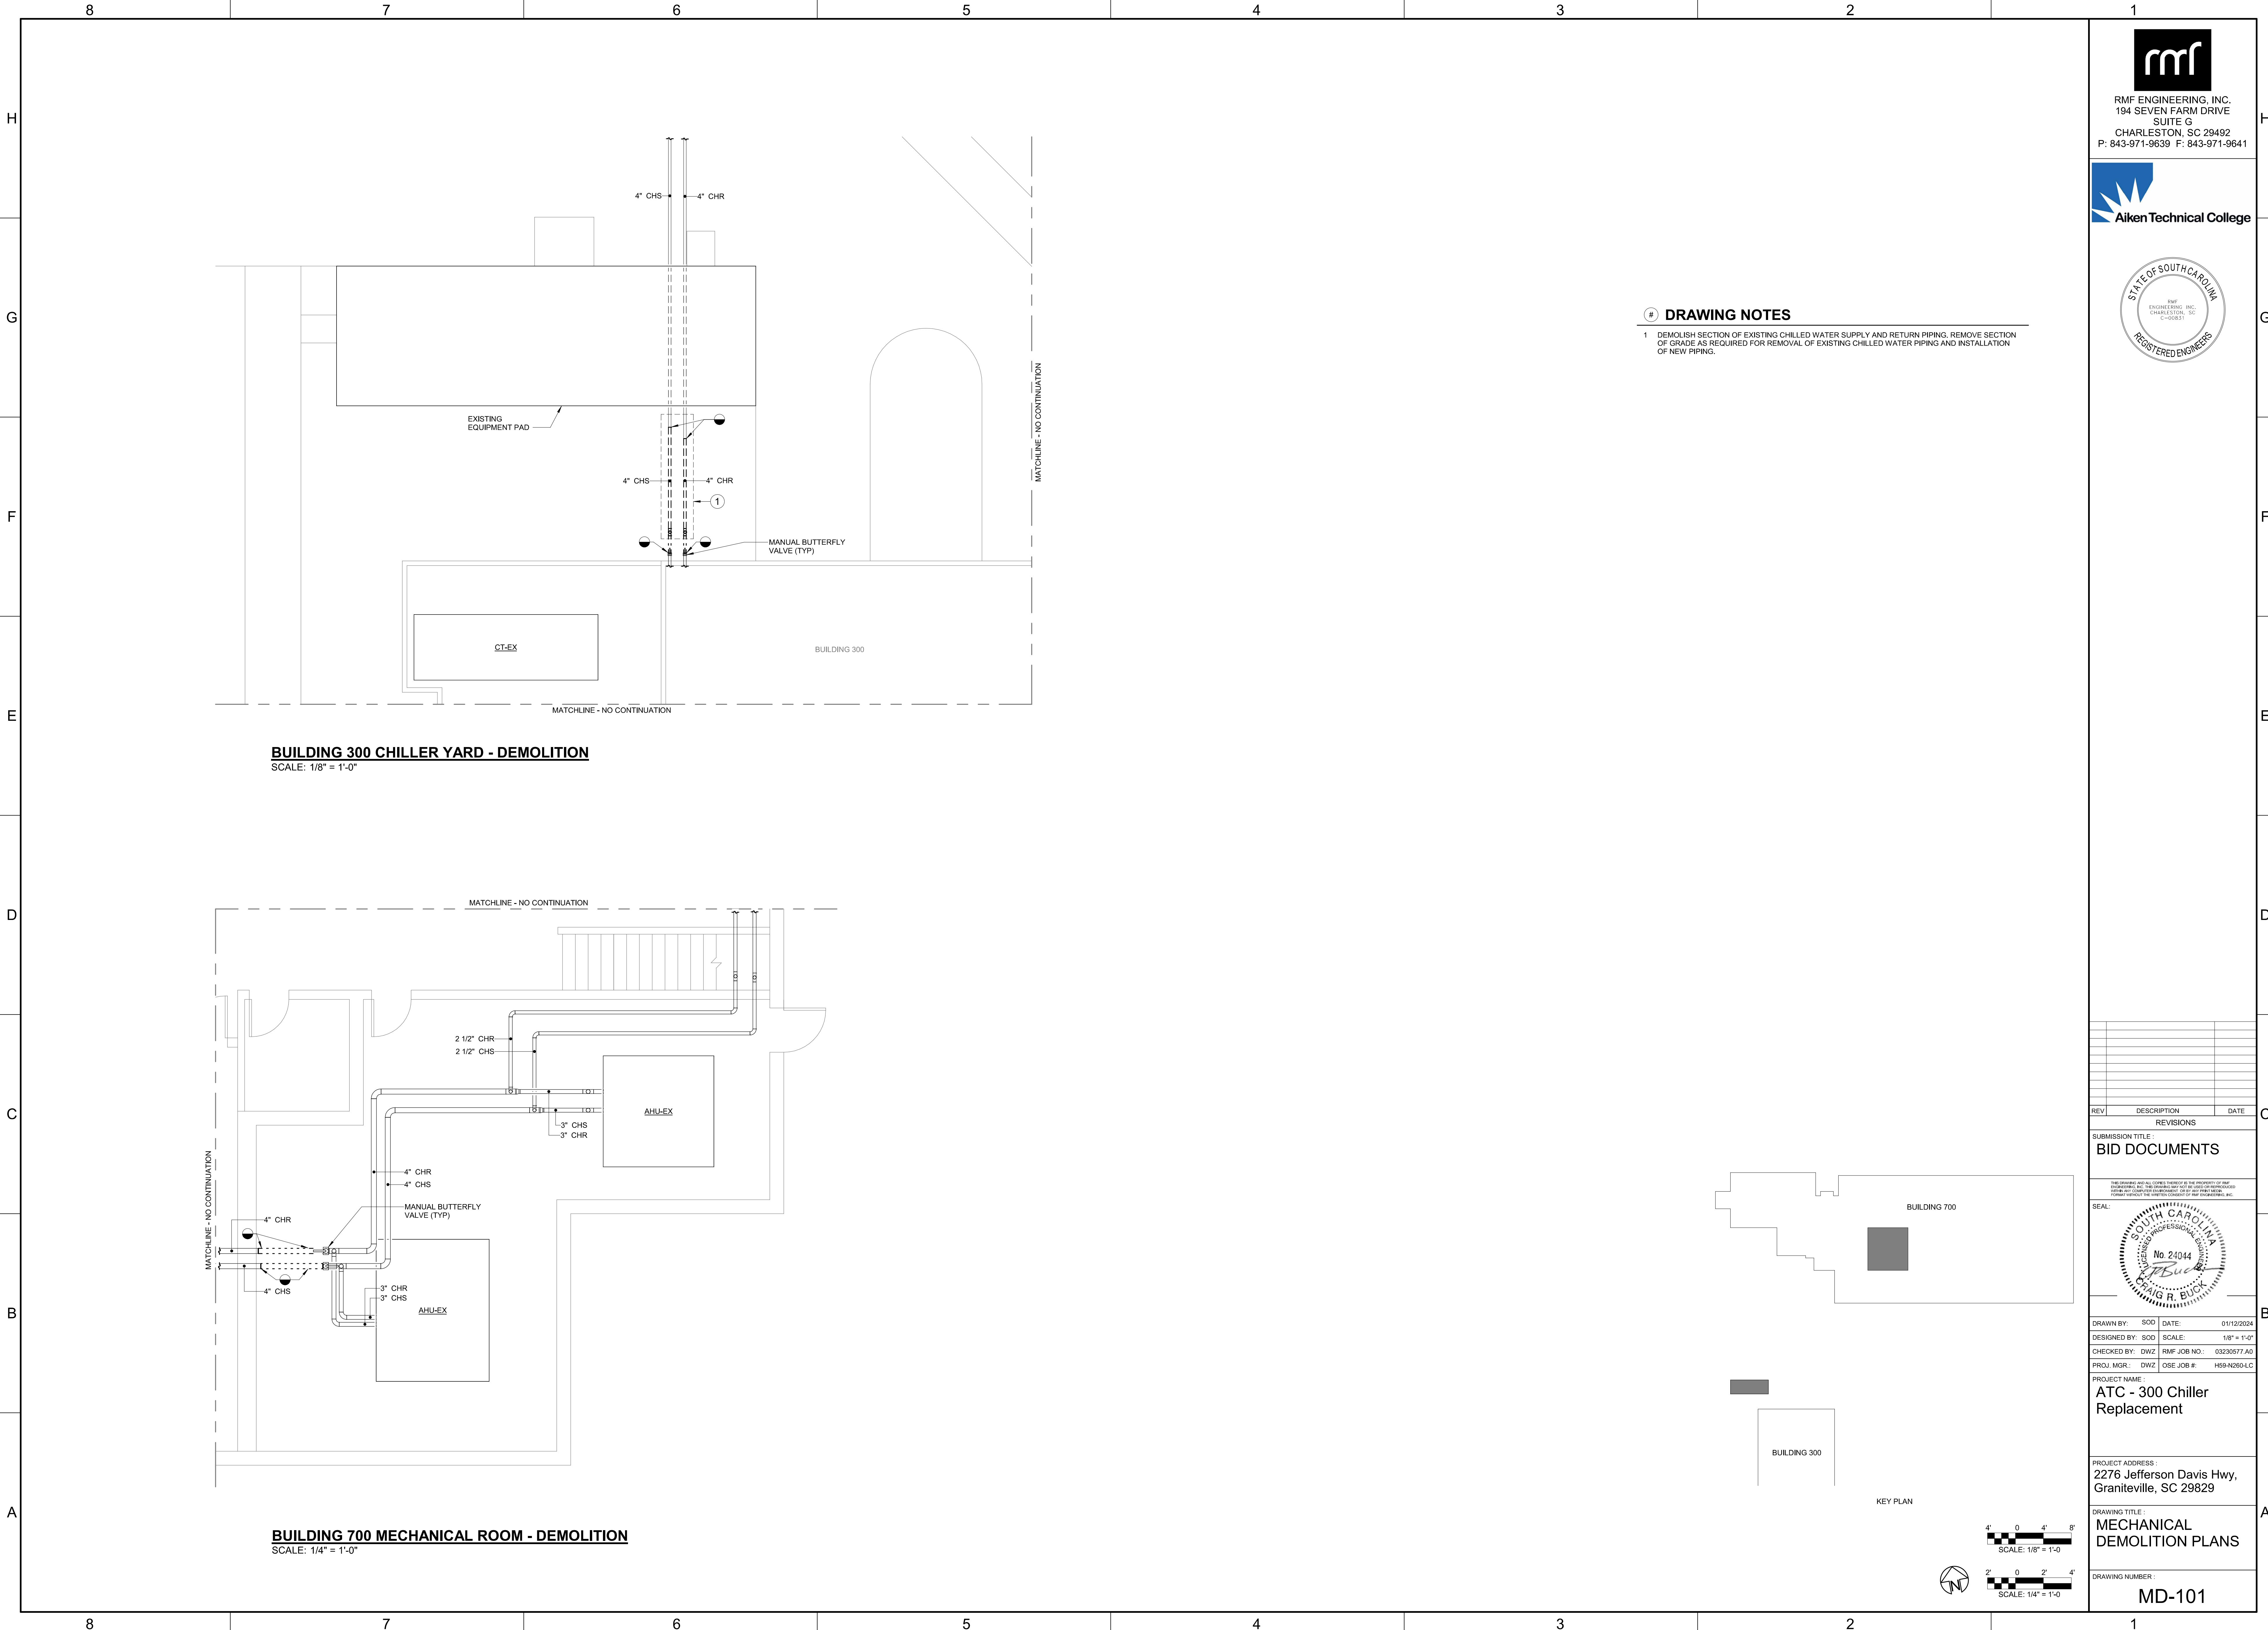

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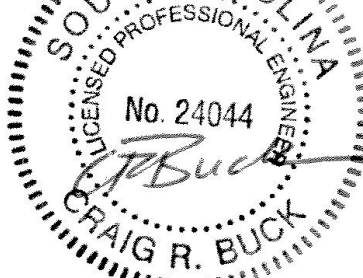
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DRAWN BY: SOD DATE: 01/12/2024

DESIGNED BY: SOD SCALE: 1/8" = 1'-0"

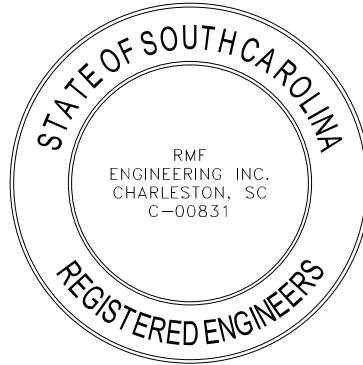CHECKED BY: DWZ RMF JOB NO.: 03230577_A0

PROJ. MGR.: DWZ OSE JOB #: H99-A260-LC

PROJECT NAME:

ATC - 300 Chiller Replacement

PROJECT ADDRESS:

2276 Jefferson Davis Hwy,
Graniteville, SC 29829

DRAWING TITLE:

MECHANICAL DEMOLITION PLANS



DRAWING NUMBER:

MD-101




1. CONNECT CHILLER AND INTEGRAL PUMPS TO THE EXISTING BUILDING 700 AUTOMATED CONTROL SYSTEM TO OPERATE AS THE EXISTING CHILLER DOES. ALL CONTROLS WORK SHALL BE CONNECTED TO THE EXISTING JOHNSON CONTROLS SYSTEM. CONTACT KEN RAPLHS AT JOHNSON CONTROLS FOR ALL CONTROLS WORK ON THIS PROJECT.

- 1 RETURN DISTURBED AREA TO ORIGINAL CONDITION.
- 2 AREA FOR CONTRACTOR CRANE SET UP AND MATERIAL LAYDOWN.
- 3 ALL CHILLED WATER PIPE IN THE CHILLER YARD SHALL BE HEAT TRACED, INSULATED, AND COVERED WITH AN ALUMINUM JACKET.
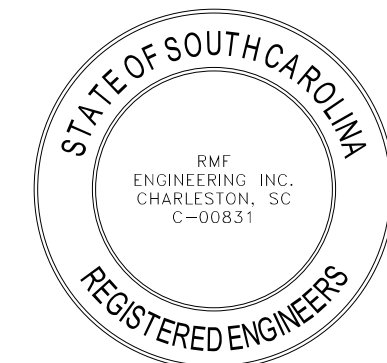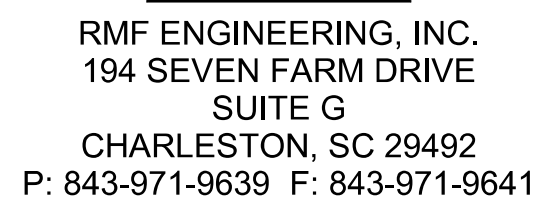
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PROJECT NAME :
**ATC - 300 Chiller
Replacement**

DRAWING TITLE :
MECHANICAL NEW
WORK PLANS

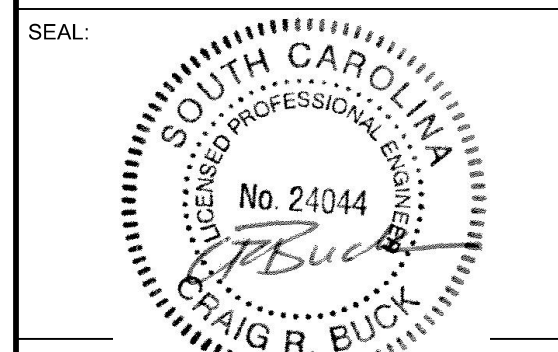DRAWING NUMBER :
M-101

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CHILLER SCHEDULE

DESIGNATION	LOCATION	TYPE	EVAPORATOR							ELECTRICAL							MAXIMUM DIMENSIONS (LxWxH)	OPERATING WEIGHT (LBS)	BASIS OF DESIGN	REMARKS	
			CAPACITY (TONS)	GPM	MIN GPM	EWT (°F)	LWT (°F)	MAX PD (FT H2O)	FOULING FACTOR	VOLTS	PHASE	HERTZ	MOCP (A)	FLA (A)	MCA (A)	LRA (A)					STARTER
CH-01	BUILDING 300 CHILLER YARD	SCROLL	150	292	150	56	44	8.8	0.0001	460	3	60	350		327	316	ACROSS THE LINE	188"x98"x89"	8523	YORK - YLAA0155	

PUMP SCHEDULE


DESIGNATION	SERVICE	TYPE	SUCTION x DISCHARGE	CAPACITY (GPM)	HEAD (FT)	NPSHR (FT)	MOTOR		RPM	EFFICIENCY (%)	PUMP QTY	VARIABLE FREQUENCY DRIVE			ELECTRICAL			BASIS OF DESIGN	REMARKS
							BHP	HP				REQUIRED	ENCLOSURE	BYPASS	VOLTS	PHASE	HERTZ		
PCHWP-01A	CHILLED WATER	VSD DUAL PUMP	4x4	146	75	10.3	7.4	10	3540	74.0	2	YES	NEMA 4X	NO	460	3	60	YORK - YLAA0155 HYDROKIT	
PCHWP-01B	CHILLED WATER	VSD DUAL PUMP	4x4	146	75	10.3	7.4	10	3540	74.0	2	YES	NEMA 4X	NO	460	3	60	YORK - YLAA0155 HYDROKIT	

EXPANSION TANK SCHEDULE


DESIGNATION	SYSTEM	TANK VOLUME (GAL)	ACCEPTANCE VOLUME (GAL)	TYPE	DIMENSIONS		DRY WEIGHT (LBS)	ORIENTATION	BASIS OF DESIGN	REMARKS
					DIAMETER	HEIGHT				
ET-01	CHILLED WATER	11	10	BLADDER	1' - 0"	2' - 3"	42	VERTICAL	WESSELS - NLAP-40	

AIR/DIRT SEPARATOR SCHEDULE



DESIGNATION	SYSTEM	FLOW RATE (GPM)	FLUID	TYPE	DIMENSIONS (IN)			SHIPPING WEIGHT (LBS)	BASIS OF DESIGN	REMARKS
					PIPE SIZE	DIAMETER	HEIGHT			
AS-01	CHILLED WATER	298	WATER	FLANGED	3	16	31	145	TACO - AC04-125	

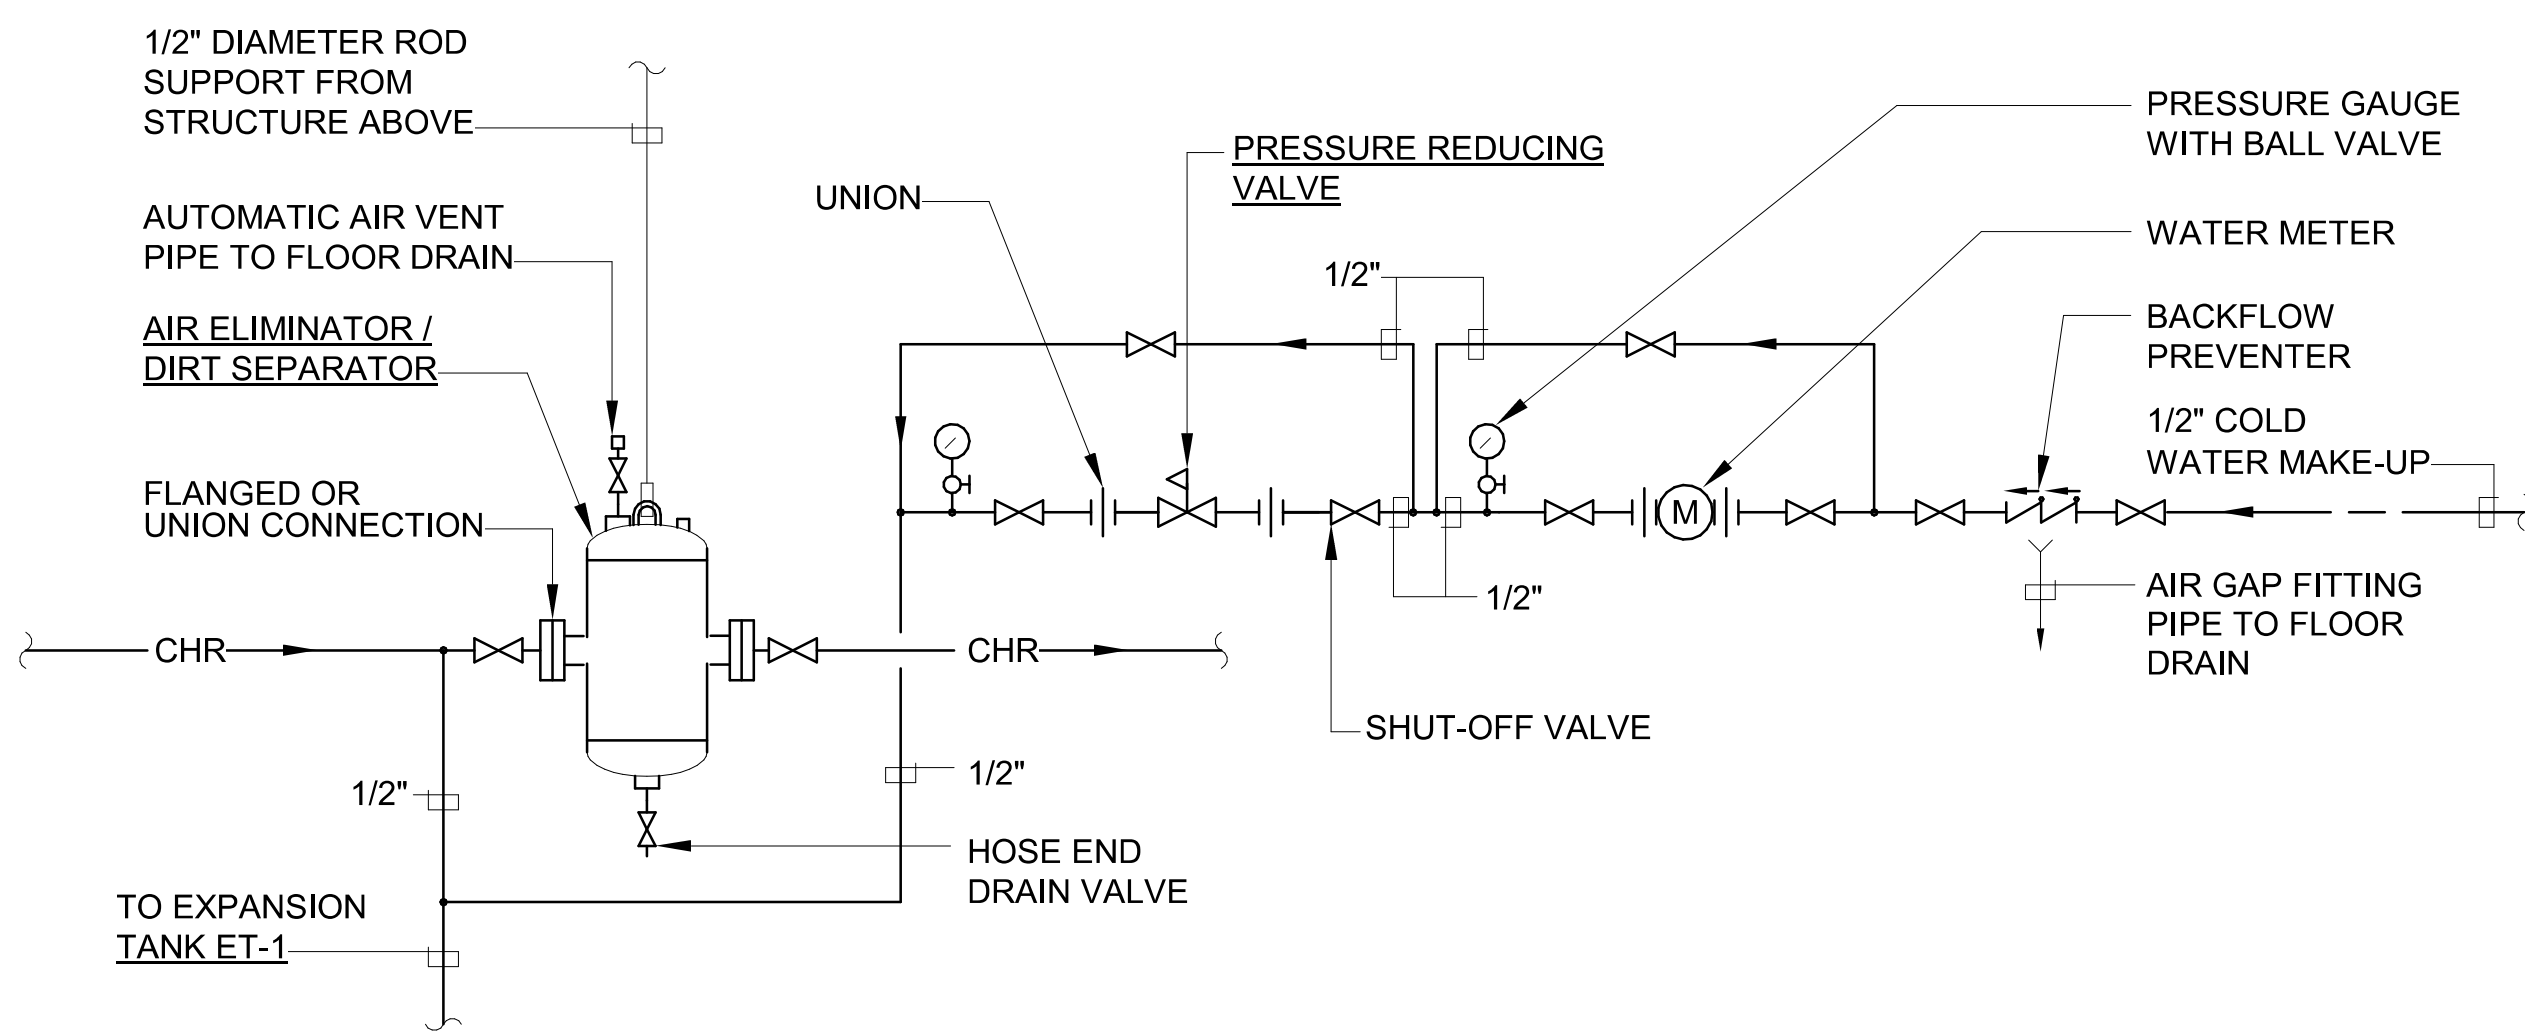

NOTES:
1. REFER TO PLANS FOR SIZE OF CHILLED WATER MAINS

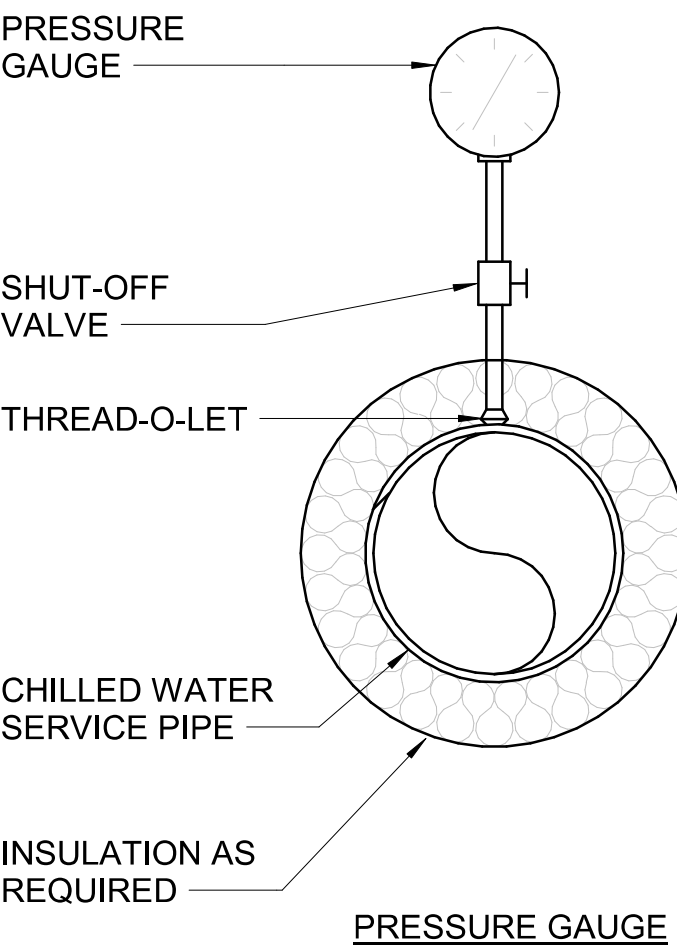

NOTE:
1. INSTALL DRAINS WHERE SHOWN ON DRAWINGS AND AT ALL LOW POINTS IN PIPING SYSTEMS.

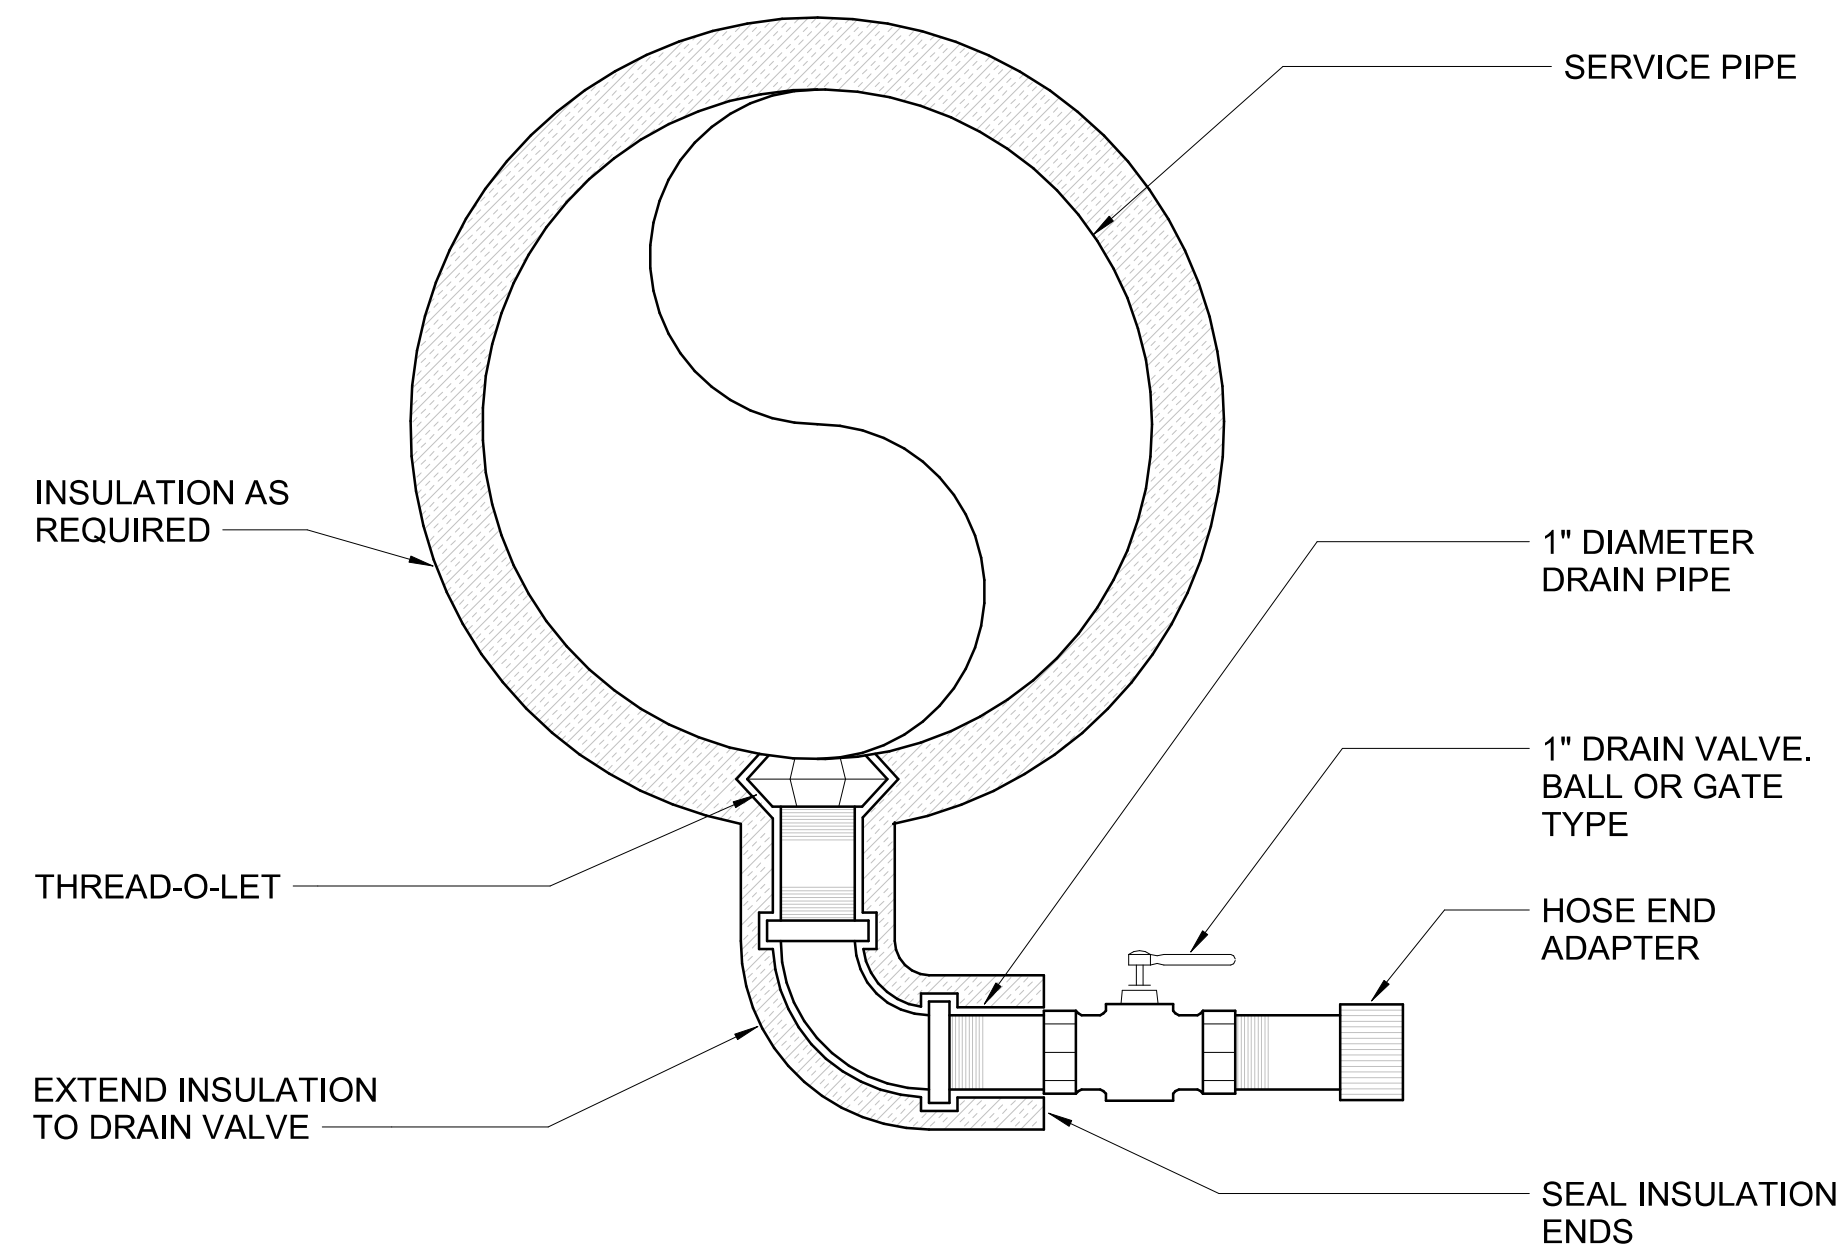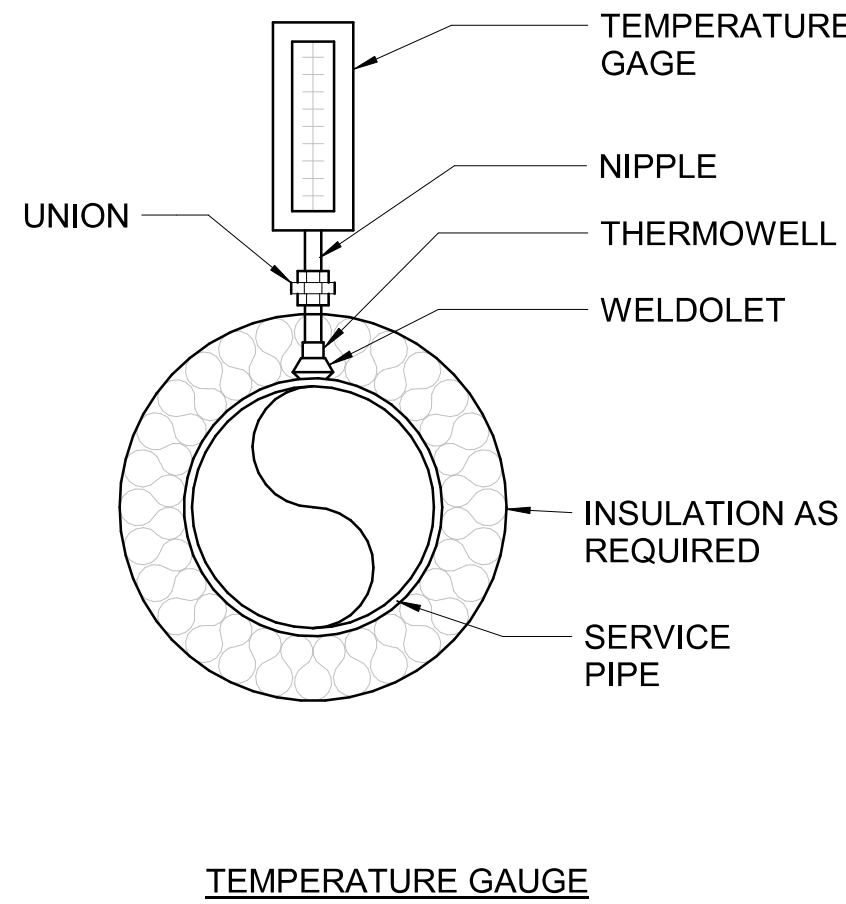


NOTES:
1. INSTALL DRAINS WHERE SHOWN ON DRAWINGS AND AT ALL LOW POINTS IN PIPING SYSTEMS.
2. FOR PIPING 6" AND LARGER, PROVIDE 2 1/2" DRAIN CONNECTION WITH VALVE AND 2 1/2" FIRE HOSE CONNECTION.


1 DETAIL - HYDRONIC MAKE-UP SYSTEM SCALE: N.T.S.

2 DETAIL - TYPICAL PIPING ACCESSORIES INSTALLATION SCALE: N.T.S.

3 DETAIL - PIPE DRAIN SCALE: N.T.S.

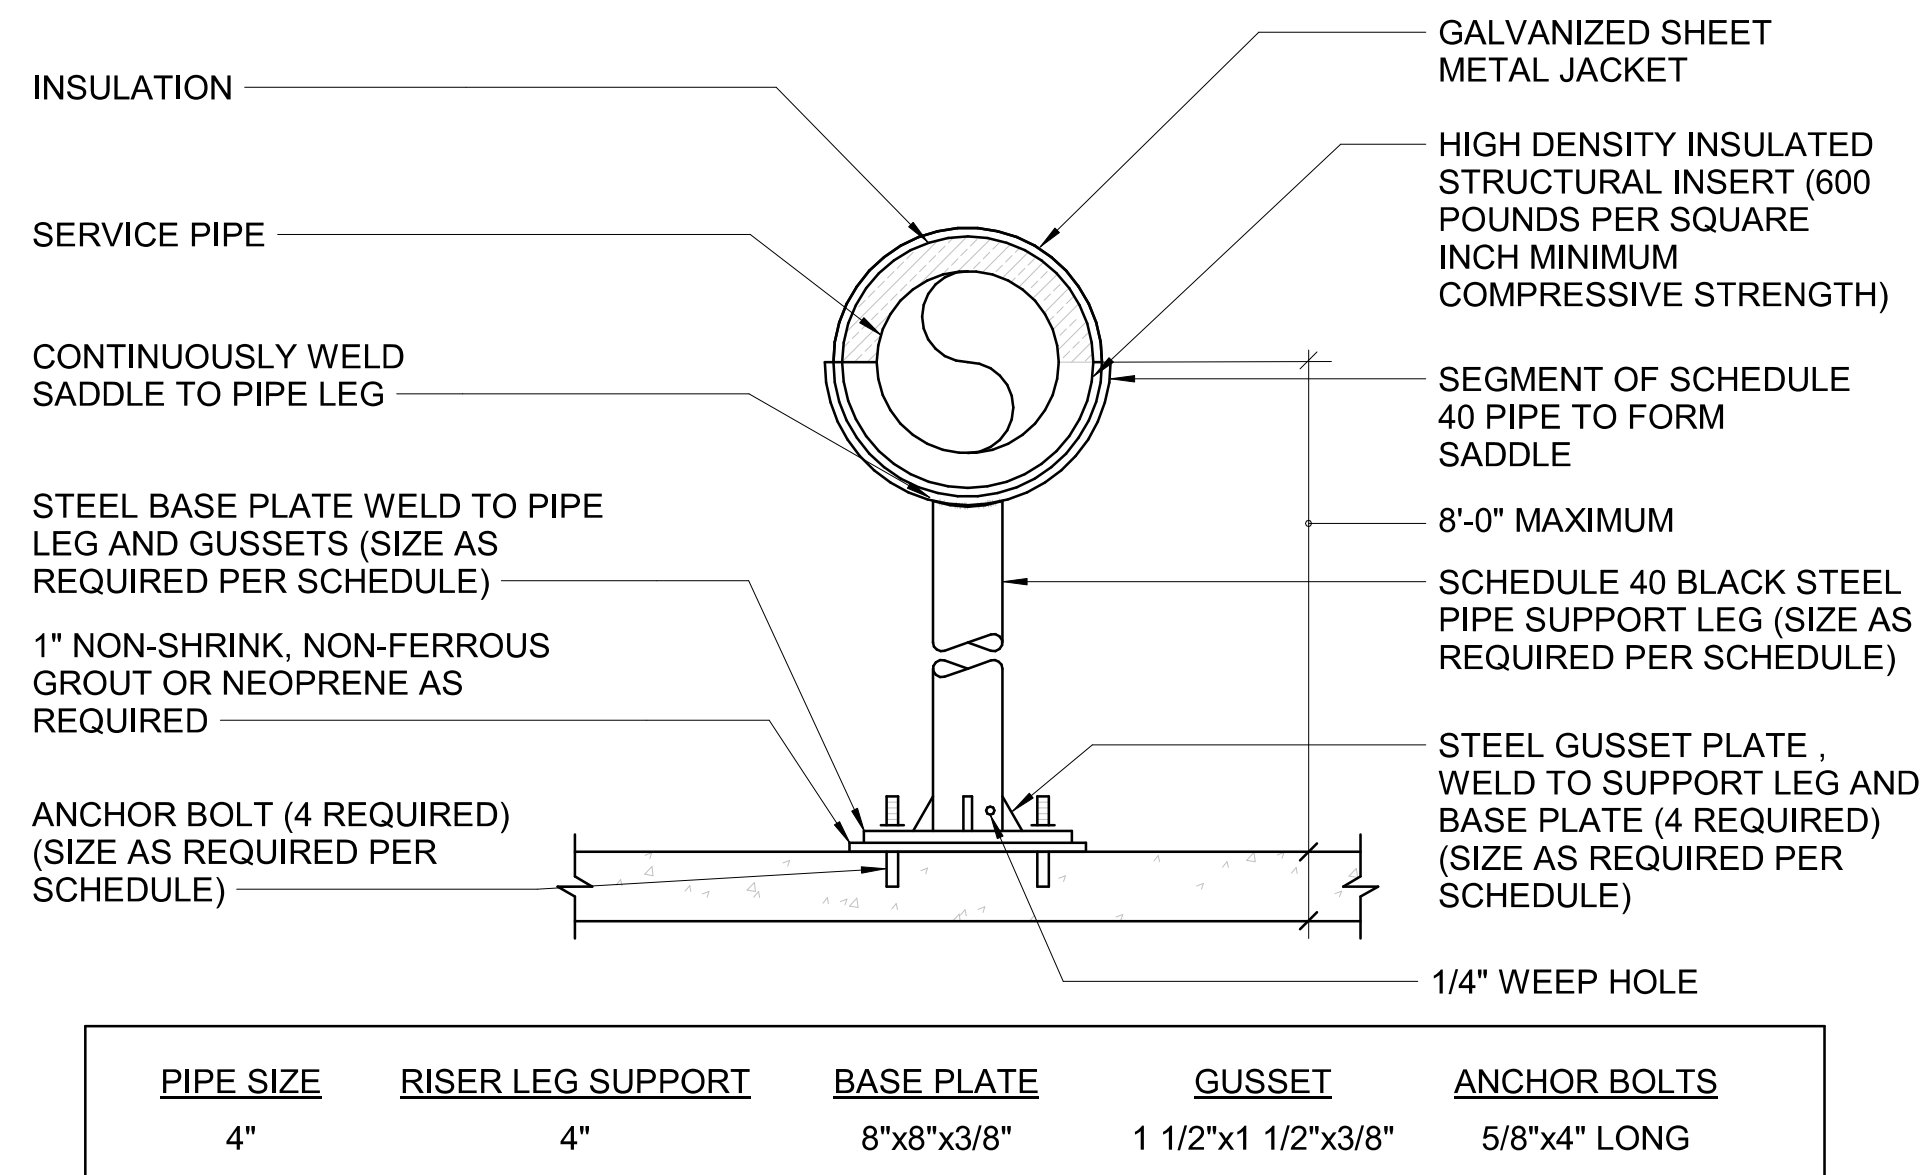

4 DETAIL - TYPICAL PIPE RISER AND SADDLE SUPPORT SCALE: N.T.S.

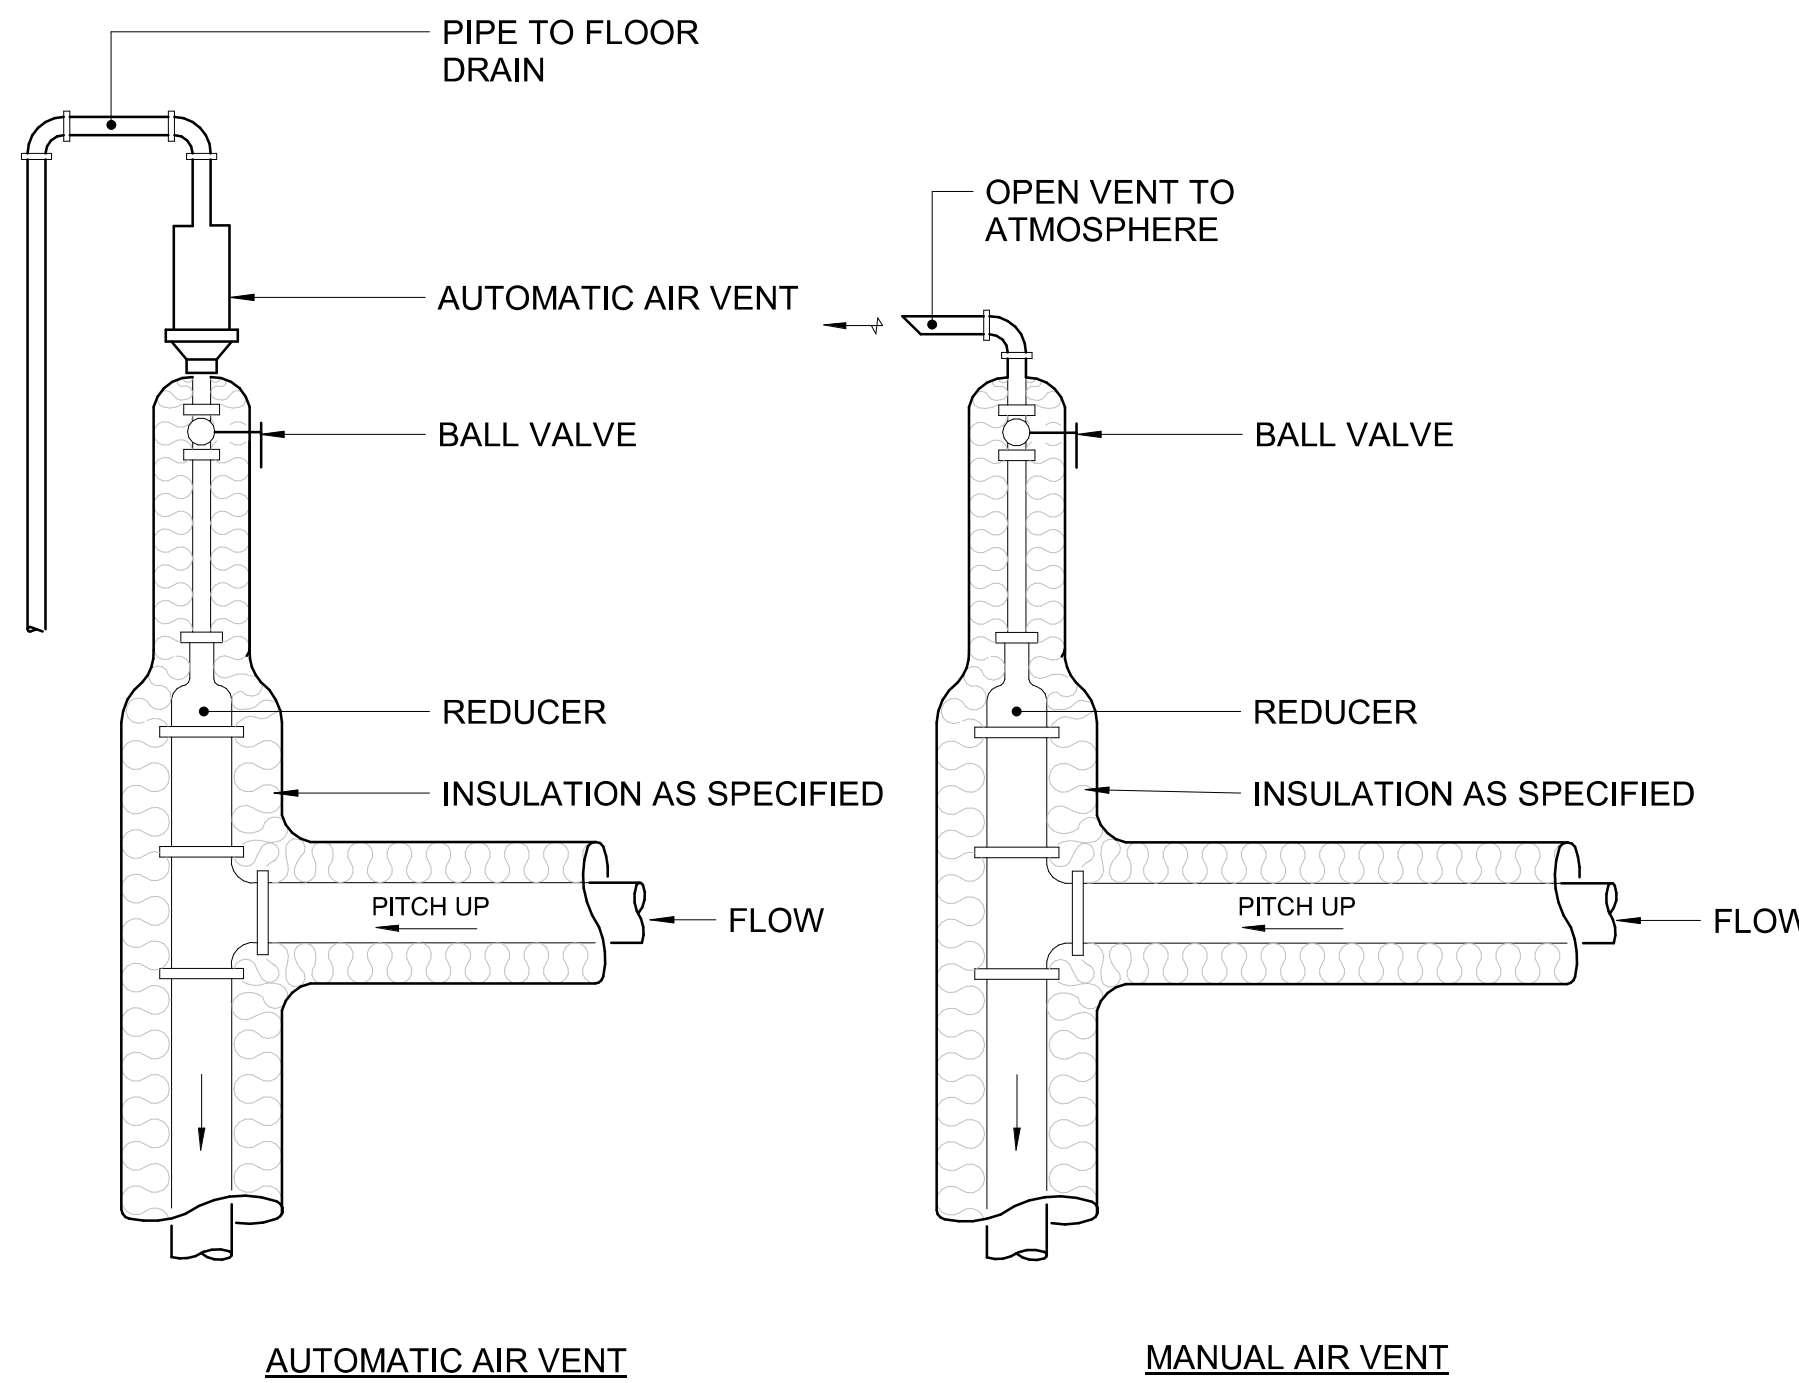


5 DETAIL - AIR VENT SCALE: N.T.S.

BUILDING DESIGN COMMISSIONING DATA	
1. OUTSIDE DESIGN CONDITIONS: SUMMER SUMMER (DEHUMIDIFICATION): WINTER:	95.3°F DB / 76.3°F WB 84.6°F DB / 79.1°F WB 27.3 °F
8. CODES: INTERNATIONAL BUILDING CODE, 2021 INTERNATIONAL MECHANICAL CODE, 2021 INTERNATIONAL PLUMBING CODE, 2021 INTERNATIONAL ENERGY CONSERVATION CODE, 2009 NATIONAL ELECTRIC CODE, 2016 NATIONAL FIRE PROTECTION ASSOCIATION STANDARDS (LATEST EDITIONS)	



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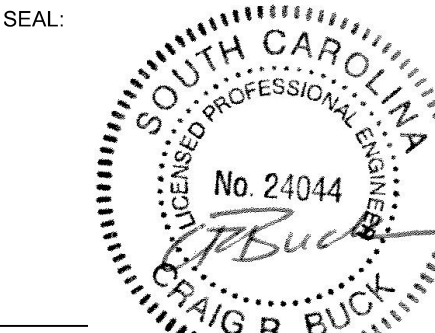
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SEAL:

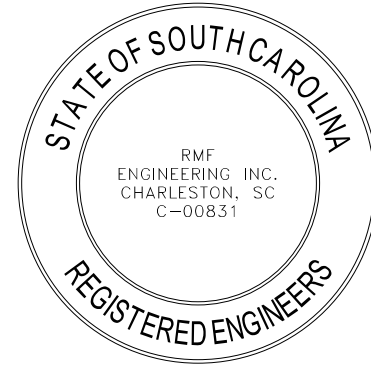

DRAWN BY: SOD DATE: 01/12/2024
DESIGNED BY: SOD SCALE: 1/8" = 1'-0"
CHECKED BY: DWZ RMF JOB NO.: 03230577.A0
PROJ. MGR.: DWZ OSE JOB #: H59-A260-LC

PROJECT NAME:
ATC - 300 Chiller Replacement

PROJECT ADDRESS:
2276 Jefferson Davis Hwy,
Graniteville, SC 29829

DRAWING TITLE:
MECHANICAL SCHEDULES AND DETAILS

DRAWING NUMBER:
M-301

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ELECTRICAL SYMBOLS									
SPECIAL SYSTEMS SYMBOLS					POWER SYMBOLS				
SYMBOL	DESCRIPTION	MH (UON)	SYMBOL	DESCRIPTION	MH (UON)	SYMBOL	DESCRIPTION	MH (UON)	SYMBOL
	FIRE ALARM HORN TYPE SPEAKER	NOTE 5		COMBINATION SWITCH AND SIMPLEX RECEPTACLE	48" TOD		RACEWAY "UP" OR "TOWARDS"	48" TOD	
	FIRE ALARM FLASHING STROBE LIGHT - WALL MOUNTED	NOTE 5		COMBINATION SWITCH AND DUPLEX RECEPTACLE	48" TOD		RACEWAY "DOWN" OR "AWAY"	48" TOD	
	FIRE ALARM HORN	NOTE 5		SIMPLEX RECEPTACLE	18" CTR		RACEWAY CONCEALED IN SLAB OR BELOW GRADE	18" CTR	
	COMBINATION FIRE ALARM HORN AND FLASHING STROBE LIGHT	NOTE 5		DUPLEX RECEPTACLE: 'E' (IF SHOWN) INDICATES CONNECTED TO EMERGENCY CIRCUIT	18" CTR		BRANCH CIRCUIT HOMERUN TO PANELBOARD: QUANTITY OF CIRCUITS INDICATED BY ARROWS	18" CTR	
	S - CEILING SPEAKER, F - FIRE ALARM SPEAKER			DUPLEX RECEPTACLE: FLOOR MOUNTED	18" CTR		NUMBER OF CONDUCTORS SHALL BE MINIMUM #12 AWG AND #12 AWG GROUND IN 3/4" CONDUIT (UON)	18" CTR	
	FIRE ALARM SPEAKER W/ STROBE			DUPLEX RECEPTACLE: SPLIT WIRED, BOTTOM HALF SWITCHED	18" CTR		RACEWAY RUN EXPOSED: CONDUCTORS SHALL BE MINIMUM 2#12 AWG AND 1#12 AWG GROUND IN 3/4" CONDUIT (UON)	18" CTR	
	HORN TYPE SPEAKER			DUPLEX RECEPTACLE: CEILING MOUNTED			BUS DUCT OR CABLE TRAY "UP" OR "TOWARDS"		
	MAGNETIC DOOR HOLDER			DUPLEX RECEPTACLE: PEDESTAL TYPE			BUS DUCT OR CABLE TRAY "DOWN" OR "AWAY"		
	DIGITAL ALARM COMMUNICATOR TRANSMITTER			DUPLEX RECEPTACLE: MOUNTED 6" ABOVE BACKSPLASH OR COUNTER	18" CTR		TELEPHONE AND POWER POLE ASSEMBLY		
	FIRE ALARM ANNUNCIATOR PANEL			DUPLEX RECEPTACLE: GROUND FAULT INTERRUPTER TYPE	18" CTR		SURFACE MOUNTED RACEWAY ASSEMBLY WITH REMOVABLE COVER		
	FIRE ALARM CONTROL PANEL			DUPLEX RECEPTACLE: GFI MOUNTED 6" ABOVE BACKSPLASH OR COUNTER	18" CTR		DARK SQUARES INDICATE PREWIRED RECEPTACLE LOCATIONS		
	RESCUE ASSISTANCE MASTER CONTROL PANEL	48" TOD		DUPLEX RECEPTACLE: MOUNTED HIGH	84" CTR		SIZE AS INDICATED MULTI-OUTLET ASSEMBLY: WITH RECEPTACLES LOCATED WHERE INDICATED		
	RESCUE ASSISTANCE REMOTE STATION	48" TOD		DUPLEX RECEPTACLE: ISOLATED GROUND	18" CTR		2 CELL MULTI-OUTLET ASSEMBLY: WITH COMMUNICATION DEVICES AND RECEPTACLES LOCATED WHERE INDICATED		
	FIRE ALARM TRANSPONDER	48" TOD		DUPLEX RECEPTACLE: AT 54" A.F.F.	54" CTR		MULTI-OUTLET ASSEMBLY: DEVICES LOCATED WHERE INDICATED		
	DOOR SOLENOID, ELECTRIC STRIKE - LOCKING DEVICE CONNECTION POINT			DOUBLE DUPLEX RECEPTACLE	18" CTR		CABLE TRAY		
	FIRE ALARM PULL STATION	48" TOD		SIMPLEX RECEPTACLE: CART RECHARGE	36" CTR		GROUND WIRE CONNECTION		
	HEAT DETECTOR: E = ELEVATOR CONTROLS			SIMPLEX RECEPTACLE: CART RECHARGE	36" CTR		GROUND WIRE		
	SMOKE DETECTOR (PHOTOELECTRIC): AB = AUDIBLE BASE, E = ELEVATOR CONTROLS			DUPLEX RECEPTACLE: PAY PHONE	54" CTR		LIGHTNING PROTECTION DOWN LEAD		
	SMOKE DETECTOR (IONIZATION)			SPECIAL RECEPTACLE: NEMA 6-20R (20A, 2P, 3W, 208V)	18" CTR		LIGHTNING PROTECTION DOWN LEAD		
	FIRE ALARM DUCT DETECTOR WITH RELAY			SPECIAL RECEPTACLE: NEMA 6-30R (30A, 2P, 3W, 208V)	18" CTR		LIGHTNING PROTECTION DOWN LEAD		
	CARBON MONOXIDE DETECTOR			SPECIAL RECEPTACLE: NEMA 14-20R (20A, 3P, 4W, 208/120V)	18" CTR		LIGHTNING PROTECTION DOWN LEAD		
	FIRE ALARM SYSTEM ADDRESSABLE RELAY - CONTROL			SPECIAL RECEPTACLE: NEMA 15-30R (30A, 3P, 4W, 208V)	18" CTR		LIGHTNING PROTECTION DOWN LEAD		
	FIRE ALARM SYSTEM ADDRESSABLE RELAY - MONITOR			SPECIAL RECEPTACLE: FLOOR MOUNTED, NEMA 6-20R	18" CTR		LIGHTNING PROTECTION DOWN LEAD		
	FIRE ALARM SYSTEM REMOTE ALARM LIGHT			SPECIAL RECEPTACLE: PEDESTAL TYPE, NEMA 6-20R	18" CTR		LIGHTNING PROTECTION DOWN LEAD		
	FLOW SWITCH CONNECTION			TELEVISION RECEPTACLE	72" CTR		LIGHTNING PROTECTION DOWN LEAD		
	TAMPER SWITCH CONNECTION			TELEVISION RECEPTACLE	18" BFC		LIGHTNING PROTECTION DOWN LEAD		
	FIRE ALARM LINEAR BEAM SMOKE DETECTOR: TRANSMITTER (LBT) AND RECEIVER (LBR)			CLOCK HANGER OUTLET	84" CTR		LIGHTNING PROTECTION DOWN LEAD		
	FIRE FIGHTER'S TELEPHONE JACK	48" TOD		PROGRAM CLOCK OUTLET: SINGLE FACE, DOUBLE FACE	84" CTR		LIGHTNING PROTECTION DOWN LEAD		
	MONITOR SYSTEM JUNCTION BOX	36" CTR		EMERGENCY POWER OFF SWITCH	48" TOD		LIGHTNING PROTECTION DOWN LEAD		
	AMPLIFIER			JUNCTION BOX	48" TOD		LIGHTNING PROTECTION DOWN LEAD		
	KEYPAD	48" TOD		JUNCTION BOX - WALL MOUNTED	48" TOD		LIGHTNING PROTECTION DOWN LEAD		
	CARD READER	48" TOD		EQUIPMENT CONNECTION AS NOTED	48" TOD		LIGHTNING PROTECTION DOWN LEAD		
	DOOR ALARM CONTACT			EQUIPMENT CONNECTION AS NOTED - WALL MOUNTED	48" TOD		LIGHTNING PROTECTION DOWN LEAD		
	ROUGH-IN JUNCTION BOX FOR CCTV CAMERA			HEATER CONNECTION - NUMBER INDICATES KILOWATTS (KW)	18" CTR		LIGHTNING PROTECTION DOWN LEAD		
	PUSH BUTTON PLATE			HEATER FAN - CEILING MOUNTED	18" CTR		LIGHTNING PROTECTION DOWN LEAD		
	TELEVISION ANTENNA OUTLET	18" CTR		ENCLOSED CIRCUIT BREAKER	18" CTR		LIGHTNING PROTECTION DOWN LEAD		
	CABLE TV OUTLET			NON-FUSED DISCONNECT SWITCH: 30A, 3P (UON)	18" CTR		LIGHTNING PROTECTION DOWN LEAD		
	TELEVISION SYSTEM SPLITTER - 2 WAY, 4 WAY			FUSED DISCONNECT SWITCH: FUSE SIZE AS INDICATED (40A)	18" CTR		LIGHTNING PROTECTION DOWN LEAD		
	AV CREDENZA LOCATION			MAGNETIC MOTOR STARTER	18" CTR		LIGHTNING PROTECTION DOWN LEAD		
	AV INPUT PLATE			COMBINATION MAGNETIC MOTOR STARTER: ABBREVIATION INDICATES TYPE - FVNR, FVR, RVAT, 2S1W, 2S2W, SST	18" CTR		LIGHTNING PROTECTION DOWN LEAD		
	AV IN-WALL RACK			VARIABLE FREQUENCY CONTROLLER W/ FUSED DISCONNECT SWITCH	18" CTR		LIGHTNING PROTECTION DOWN LEAD		
	AV MONITOR TV			VARIABLE FREQUENCY DRIVE W/ DISCONNECT SWITCH	18" CTR		LIGHTNING PROTECTION DOWN LEAD		
	AV SCREEN CONTROL			MOTOR: NUMERALS (IF SHOWN) INDICATE HP	18" CTR		LIGHTNING PROTECTION DOWN LEAD		
	AV SCHEDULING PANEL			GENERATOR: NUMERALS (IF SHOWN) INDICATE KW	18" CTR		LIGHTNING PROTECTION DOWN LEAD		
	AV SIGNAGE TV			MANUAL MOTOR STARTER W/ THERMAL OVERLOADS	18" CTR		LIGHTNING PROTECTION DOWN LEAD		
	AV TOUCH PANEL			MOTOR SWITCH	18" CTR		LIGHTNING PROTECTION DOWN LEAD		
	DATA/TELEPHONE OUTLET, CEILING MOUNTED			MECHANICAL EQUIPMENT CONNECTION - WITH MOTOR	18" CTR		LIGHTNING PROTECTION DOWN LEAD		
	TELEPHONE OUTLET	18" CTR		MECHANICAL EQUIPMENT CONNECTION - NO MOTOR	18" CTR		LIGHTNING PROTECTION DOWN LEAD		
	DATA OUTLET	18" CTR		CONTROL PANEL: TYPE AS INDICATED	18" CTR		LIGHTNING PROTECTION DOWN LEAD		
	TELEPHONE OUTLET, WALL MOUNTED	54" CTR		MOMENTARY CONTACT START-STOP PUSHBUTTON STATION	48" TOD		LIGHTNING PROTECTION DOWN LEAD		
	TELEPHONE OUTLET, EMERGENCY	54" TOD		MAINTAINED CONTACT START-STOP PUSHBUTTON STATION	48" TOD		LIGHTNING PROTECTION DOWN LEAD		
	DATA/TELEPHONE OUTLET: UNSHADED AREA = DATA, SHADED AREA = VOICE	18" CTR		MAINTAINED CONTACT EMERGENCY STOP PUSHBUTTON STATION	48" TOD		LIGHTNING PROTECTION DOWN LEAD		
	DATA/TELEPHONE OUTLET: UNSHADED AREA = DATA, SHADED AREA = VOICE	18" CTR		BRANCH PANELBOARD	90" TOC		LIGHTNING PROTECTION DOWN LEAD		
	DATA/TELEPHONE OUTLET: UNSHADED AREA = DATA, SHADED AREA = VOICE	18" CTR		DISTRIBUTION PANELBOARD	90" TOC		LIGHTNING PROTECTION DOWN LEAD		
	COMBINATION POWER & TELEPHONE OUTLET, FLOOR MOUNTED			TRANSFORMER, CONCRETE PAD MOUNTED	90" TOC		LIGHTNING PROTECTION DOWN LEAD		
	COMBINATION POWER & DATA OUTLET, FLOOR MOUNTED						LIGHTNING PROTECTION DOWN LEAD		
	COMBINATION POWER & DATA/TELEPHONE OUTLET, FLOOR MOUNTED						LIGHTNING PROTECTION DOWN LEAD		
	WIRELESS ACCESS POINT						LIGHTNING PROTECTION DOWN LEAD		

CIRCUIT DESIGNATIONS	
LIGHTING	POWER
FIXTURE TYPE	CIRCUIT DESIGNATION (#12AWG MINIMUM)
CIRCUIT DESIGNATION (#12AWG MINIMUM)	CIRCUIT DESIGNATION (#12AWG MINIMUM)
SWITCH DESIGNATION	

EQUIPMENT DESIGNATIONS	
SYMBOL	DESCRIPTION
	SW/GR
	SW/BD
	PNL
	MCC
	XFMR

ELECTRICAL DRAWING PRESENTATION	
SYMBOL	DESCRIPTION
	REVISION NUMBER
	DRAWING NOTE NUMBER
	SECTION/ELEVATION IDENTIFICATION
	PART PLAN AND DETAIL IDENTIFICATION
	EXISTING LINE TYPE
	NEW ELECTRICAL WORK LINE TYPE
	FUTURE ELECTRICAL WORK LINE TYPE
	DEMOLITION LINE TYPE ON DEMOLITION DRAWINGS

NOTE: THIS IS A STANDARD SYMBOL LIST. SOME SYMBOLS MAY NOT APPEAR ON THE ACCOMPANYING DRAWINGS.

1. THIS IS A STANDARD SYMBOL LIST. SOME SYMBOLS MAY NOT APPEAR ON THE ACCOMPANYING DRAWINGS.

2. REFER TO SPECIFICATIONS FOR DETAILED REQUIREMENTS.

3. PLAN AND SECTION SYMBOLS MAY ALSO BE USED ON RISER DIAGRAMS.

4. ON SINGLE LINE DIAGRAMS FOR 3 PHASE SYSTEMS, DEVICE QUANTITY = 3, UNLESS OTHERWISE NOTED.

5. DEVICE SHALL BE MOUNTED A MINIMUM OF 90" AFF TO BOTTOM OF DEVICE OR BELOW THE FINISHED CEILING OR NOT LESS THAN 6" TO TOP OF DEVICE, WHICHEVER IS LOWER.

6. UNLESS OTHERWISE NOTED, ALL INTERIOR CONDUITS AND BOXES SHALL BE CONCEALED.

NOTE: THIS IS A STANDARD ABBREVIATION LIST. SOME ABBREVIATIONS MAY NOT APPEAR ON THE ACCOMPANYING DRAWINGS.

2S1W 2 SPEED SINGLE WINDING

2S2W 2 SPEED DOUBLE WINDING

A AMP

A/C AMPERE

AC AIR CONDITIONING

AC ALTERNATING CURRENT

AFCI ARC FAULT CIRCUIT INTERRUPTER

AF ABOVE FINISHED FLOOR

AFG ABOVE FINAL GRADE

AHU AIR HANDLING UNIT

AIC AMPS INTERRUPTING CAPACITY

ALT ALTERNATE


ANN ANNUNCIATOR

APPROX APPROXIMATELY


<

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1
ELECTRICAL SITE PLAN
SCALE: 1" = 20'-0"

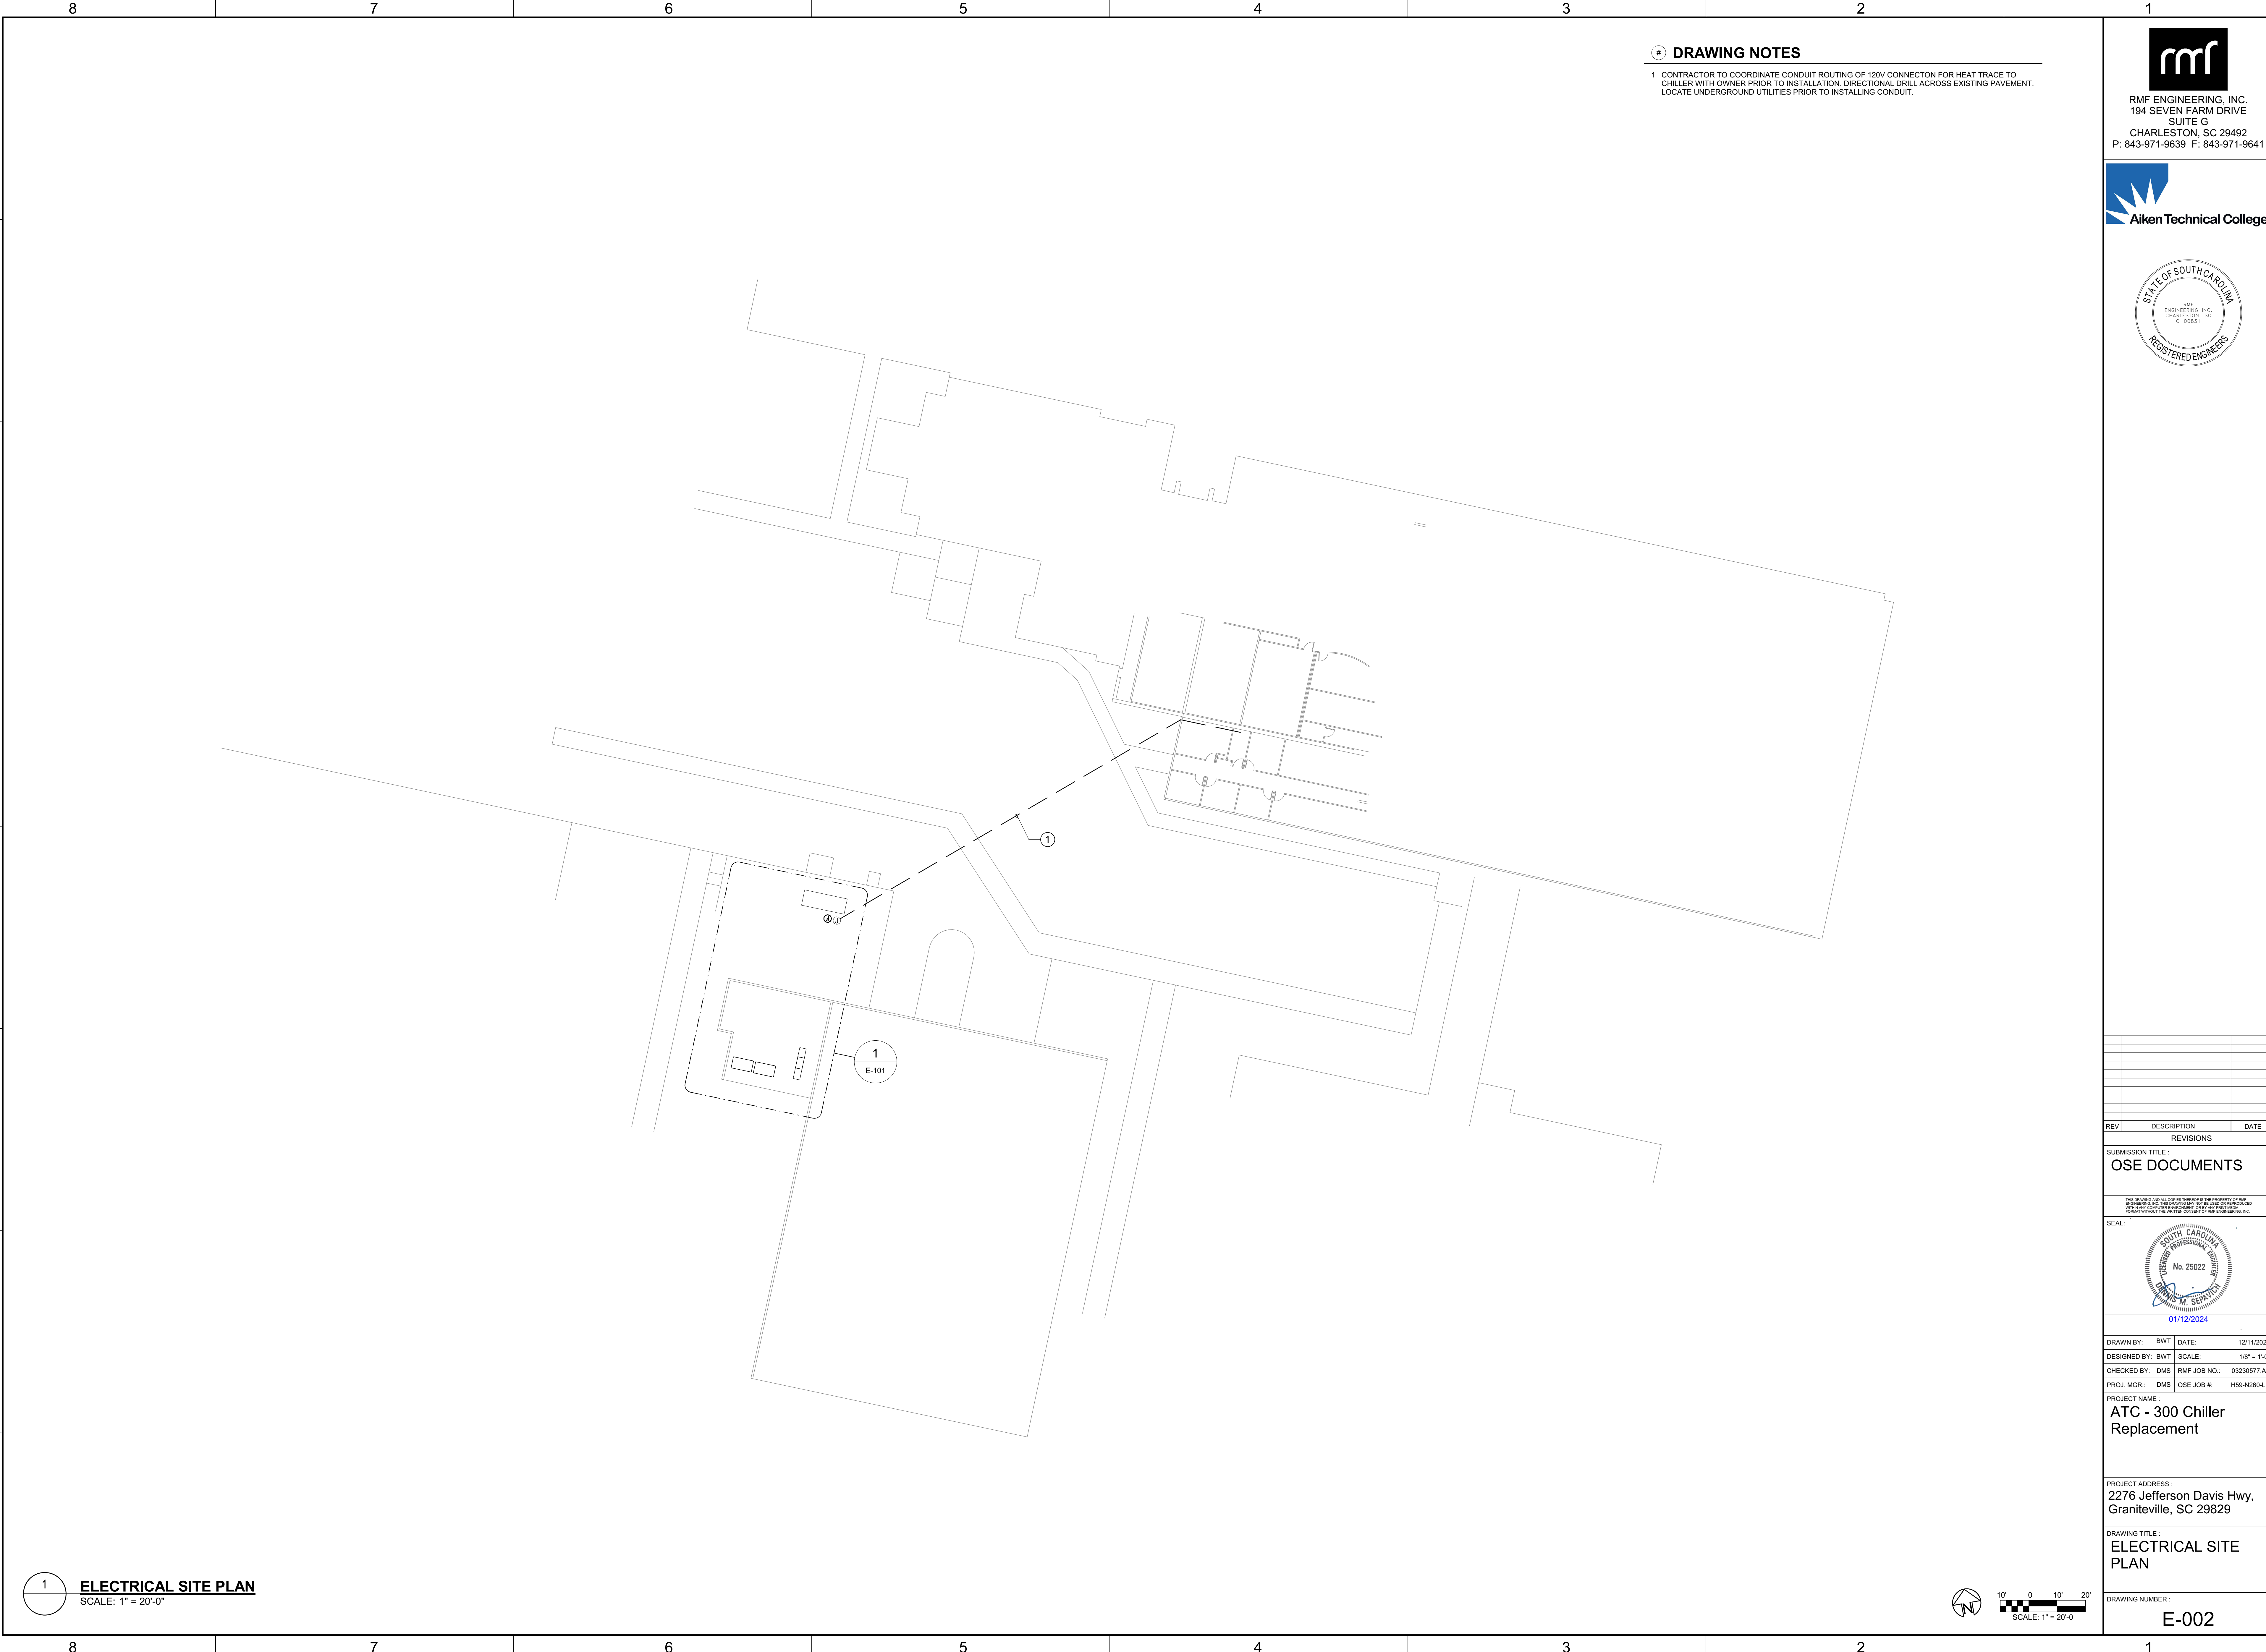


DRAWING NOTES

1 CONTRACTOR TO COORDINATE CONDUIT ROUTING OF 120V CONNECTION FOR HEAT TRACE TO CHILLER WITH OWNER PRIOR TO INSTALLATION. DIRECTIONAL DRILL ACROSS EXISTING PAVEMENT. LOCATE UNDERGROUND UTILITIES PRIOR TO INSTALLING CONDUIT.

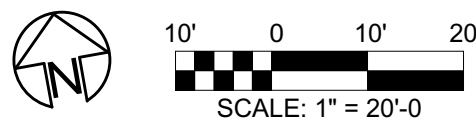

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194 SEVEN FARM DRIVE
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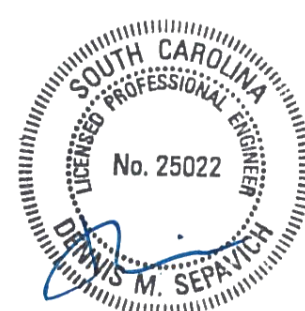
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SEAL:

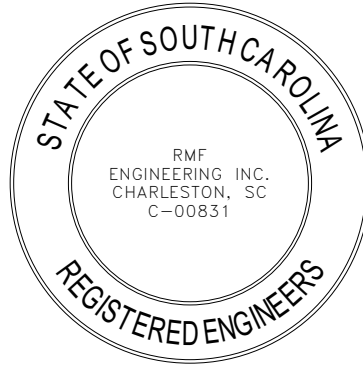

DRAWN BY: BWT DATE: 12/11/2023

DESIGNED BY: BWT SCALE: 1/8" = 1'-0"

CHECKED BY: DMS RMF JOB NO.: 03230577.A0

PROJ. MGR.: DMS OSE JOB #: H59-N260-LC

PROJECT NAME:
ATC - 300 Chiller Replacement

PROJECT ADDRESS:
**2276 Jefferson Davis Hwy,
Graniteville, SC 29829**

DRAWING TITLE:
ELECTRICAL SITE PLAN

DRAWING NUMBER:
E-002

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DRAWING NOTES

- 1 120V CONNECTION FOR HEAT TRACE. PROVIDE 120V, 1-PHASE, 30mA GROUND FAULT BREAKER IN EXISTING PANEL C1. PROVIDE 2#10AWG + 1#10GRD IN 1" CONDUIT FROM PANEL TO HEAT TRACE JUNCTION BOX AT CHILLER. COORDINATE WITH MECHANICAL CONTRACTOR FOR EXACT LOCATION OF HEAT TRACE CONNECTION PRIOR TO INSTALLATION. SEE SHEET E-002 FOR ADDITIONAL INFORMATION.
- 2 REFER TO PANEL SCHEDULE FOR CONDUIT AND WIRE SIZE. COORDINATE CONDUIT ROUTING WITH EXISTING UNDERGROUND COOLING TOWER PIPING. EXERCISE CAUTION AND LOCATE UNDERGROUND PIPING PRIOR TO INSTALLTION OF CONDUIT. HAND DIG IN AREA OF PIPING TO AVOID DAMAGING THE EXISTING PIPING.
- 3 120V CONNECTION FOR EVAPORATOR HEATER. PROVIDE 120V, 20A CIRCUIT (2#10, 1#10GRD IN 1" CONDUIT) FROM PANEL TO HEATER. COORDINATE WITH MECHANICAL CONTRACTOR FOR EXACT LOCATION PRIOR TO INSTALLATION.

REV	DESCRIPTION	DATE
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REVISIONS

SUBMISSION TITLE:

OSE DOCUMENTS

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SEAL:



DRAWN BY: BWT DATE: 12/11/2023

DESIGNED BY: BWT SCALE: 1/8" = 1'-0"

CHECKED BY: DMS RMF JOB NO.: 03230577.A0

PROJ. MGR.: DMS OSE JOB #: H59-N260-LC

PROJECT NAME:
ATC - 300 Chiller Replacement


PROJECT ADDRESS:
2276 Jefferson Davis Hwy,
Graniteville, SC 29829

DRAWING TITLE:
ELECTRICAL POWER PLAN

DRAWING NUMBER:
E-101

1 BUILDING 300 CHILLER YARD - ELECTRICAL
SCALE: 1/8" = 1'-0"

2 BUILDING 700 MECHANICAL ROOM - ELECTRICAL
SCALE: 1/4" = 1'-0"

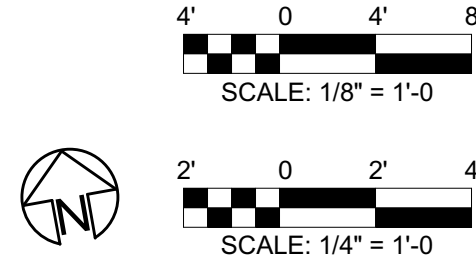


Autodesk Docs\03230577\AO-ATC Building 300 Chiller Replacement\03230577_AO_MEP_23.rvt

1/12/2024 11:31:12 AM



RMF ENGINEERING, INC.
194 SEVEN FARM DRIVE
SUITE G
CHARLESTON, SC 29492
P: 843-971-9639 F: 843-971-9641

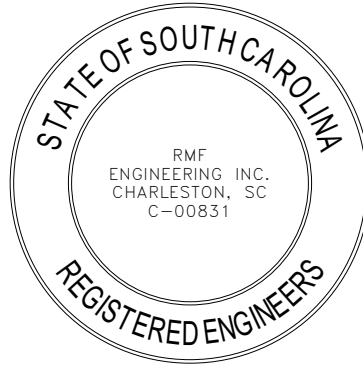

DRAWING NOTES

- CONTRACTOR TO PROVIDE BREAKERS SHOWN ON PANEL. BREAKER SHALL MATCH EXISTING GE SWITCHGEAR.
- CONTRACTOR TO PROVIDE BREAKERS SHOWN ON PANEL. BREAKER SHALL MATCH EXISTING SQUARE D TYPE NGOD PANELBOARD.
- CONTRACTOR TO PROVIDE BREAKER SHOWN ON PANEL. BREAKER SHALL MATCH EXISTING EATON TYPE PRL1A PANELBOARD.

PANELBOARD: EX MDP1		MAINS: 2000A MCB		AMPS: 2000 A		MIN AIC: 50,000		
LOCATION:		VOLTS: 480/277 Wye		PHASE: 3		WIRES: 4		
MOUNTING: FREE STANDING		ENCL NEMA: 3R		NOTES: EXISTING SWITCHGEAR				
ITEM NO.	EQUIPMENT SERVED	P	TRIP AMPS	WIRE	GRD	CND	KVA CONN	KVA DEMAND
1	SPARE	3	20 A	--	--	--	0.00 KVA	--
2	EXISTING LOAD - PANEL EA	3	1200 A	--	--	--	0.00 KVA	--
3	EXISTING LOAD - PANEL PDP2	3	250 A	--	--	--	0.00 KVA	--
4	EXISTING LOAD - LIGHTING PANEL	3	125 A	--	--	--	0.00 KVA	--
5	CH-01	3	350 A	3#500	1#3	3 1/2"	271.87 KVA	--
6	SPACE	3	--	--	--	--	--	--
7	EXISTING LOAD - PANEL PDP1	3	1800 A	--	--	--	0.00 KVA	--
8	EXISTING LOAD - PANEL MDP1	3	2000 A	--	--	--	0.00 KVA	--
9								
10								
11								
12							271.87 KVA	

PANELBOARD: EX PNL C1																			
LOCATION:					MAINS: MCB					AMPS: 100									
MOUNTING: Surface					VOLTS: 208/120 Wye														
ENCL NEMA: Type 1					PHASE: 3														
MIN AIC: SEE ONE-LINE DIAGRAM					WIRES: 4					EXISTING PANEL									
PANEL NOTES:																			
PROVIDE GROUND BUS																			
PROVIDE FULL SIZE NEUTRAL BUS UNLESS NOTED OTHERWISE																			
WIRE SIZE	LOAD DESCRIPTION	P	TRIP AMPS	TYPE	CKT	A	B		C		CKT	TYPE	TRIP AMPS	P	LOAD DESCRIPTION	WIRE SIZE			
--	EXISTING LOAD	1	20 A	--	1	0.00	0.00				2	--	20 A	1	EXISTING LOAD	--			
--	EXISTING LOAD	1	20 A	--	3			0.00	0.00		4	--	20 A	1	EXISTING LOAD	--			
--	EXISTING LOAD	1	20 A	--	5					0.00	0.00	6	--	20 A	1	EXISTING LOAD	--		
--	EXISTING LOAD	1	20 A	--	7	0.00	0.00					8	--	20 A	1	EXISTING LOAD	--		
--	EXISTING LOAD	1	20 A	--	9			0.00	0.00			10	--	20 A	1	EXISTING LOAD	--		
--	EXISTING LOAD	1	20 A	--	11					0.00	0.00	12	--	20 A	1	EXISTING LOAD	--		
--	EXISTING LOAD	1	20 A	--	13	0.00	0.00					14	--	20 A	1	EXISTING LOAD	--		
--	EXISTING LOAD	1	20 A	--	15			0.00	0.00			16	--	20 A	1	EXISTING LOAD	--		
--	EXISTING LOAD	1	20 A	--	17					0.00	0.00	18	--	20 A	1	EXISTING LOAD	--		
--	EXISTING LOAD	1	20 A	--	19	0.00	0.00					20	--	20 A	1	EXISTING LOAD	--		
--	EXISTING LOAD	1	20 A	--	21			0.00	0.00			22	--	20 A	1	EXISTING LOAD	--		
--	EXISTING LOAD	1	20 A	--	23					0.00	0.00	24	--	20 A	1	EXISTING LOAD	--		
--	EXISTING LOAD	1	20 A	--	25	0.00	0.00					26	--	20 A	1	EXISTING LOAD	--		
--	EXISTING LOAD	1	20 A	--	27			0.00	1.00			28	HT	20 A	1	HEAT TRACE	--		
--	EXISTING LOAD	1	20 A	--	29					0.00	1.00	30	20 A	1	EVAP HEATER	--			
--	SPACE	1	--	--	31	--	--					32	--	--	1	SPACE	--		
--	SPACE	1	--	--	33			--	--			34	--	--	1	SPACE	--		
--	SPACE	1	--	--	35					--	--	36	--	--	1	SPACE	--		
--	SPACE	1	--	--	37	--	--					38	--	--	1	SPACE	--		
--	SPACE	1	--	--	39			--	--			40	--	--	1	SPACE	--		
--	SPACE	1	--	--	41					--	--	42	--	--	1	SPACE	--		
TOTAL LOAD:						0.00 KVA	1.00 KVA	1.00 KVA											
BREAKER TYPE KEYS:																			
LO - INDICATES C.B. EQUIPPED WITH "LOCK-ON" DEVICE																			
GF - INDICATES C.B. IS GROUND FAULT TYPE (5mA FOR PERSONNEL)																			
ST - INDICATES C.B. EQUIPPED WITH SHUNT TRIP DEVICE																			
HT - INDICATES C.B. EQUIPPED WITH 30mA GROUND FAULT FOR EQUIPMENT																			
Load Classification	Connected Load					Demand Factor					Estimated Demand					Panel Totals			
Equipment	2.00					100.00%					2.00								
													Total Conn. Load: 2.00 KVA						
													Total Est. Demand: 2.00 KVA						
													Total Conn. Current: 5.55 A						
													Total Est. Demand Current: 5.55 A						

PANELBOARD: EX PNL LA1																	
LOCATION:				MAINS:				AMPS: 225									
MOUNTING: Surface				VOLTS: 208/120 Wye													
ENCL NEMA: Type 1				PHASE: 3													
MIN AIC: SEE ONE-LINE DIAGRAM				WIRES: 4				EXISTING PANEL									
PANEL NOTES:																	
PROVIDE GROUND BUS																	
PROVIDE FULL SIZE NEUTRAL BUS UNLESS NOTED OTHERWISE																	
WIRE SIZE	LOAD DESCRIPTION	P	TRIP AMPS	TYPE	CKT	A		B		C		CKT	TYPE	TRIP AMPS	P	LOAD DESCRIPTION	WIRE SIZE
--	EXISTING LOAD	1	20 A	--	1	0.00	0.00					2	--	20 A	1	EXISTING LOAD	--
--	EXISTING LOAD	1	20 A	--	3			0.00	0.00			4	--	20 A	1	EXISTING LOAD	--
--	EXISTING LOAD	1	20 A	--	5					0.00	0.00	6	--	20 A	1	EXISTING LOAD	--
--	EXISTING LOAD	1	20 A	--	7	0.00	0.00					8	--	20 A	1	EXISTING LOAD	--
--	EXISTING LOAD	1	20 A	--	9			0.00	0.00			10	--	20 A	1	EXISTING LOAD	--
--	EXISTING LOAD	1	20 A	--	11					0.00	0.00	12	--	20 A	1	EXISTING LOAD	--
--	EXISTING LOAD	1	20 A	--	13	0.00	0.18					14	--	20 A	1	ATC PANEL	--
--	EXISTING LOAD	1	20 A	--	15			0.00	--			16	--	--	1	SPACE	--
--	EXISTING LOAD	1	20 A	--	17					0.00	--	18	--	--	1	SPACE	--
--	EXISTING LOAD	1	20 A	--	19	0.00	0.00					20	--	--	--	--	--
--	EXISTING LOAD	1	20 A	--	21			0.00	0.00			22	--	50 A	2	EXISTING LOAD	--
--	EXISTING LOAD	1	20 A	--	23					0.00	0.00	24	--	--	--	--	--
--	SPARE	3	20 A	--	25	0.00	0.00					26	--	20 A	3	EXISTING LOAD	--
27							0.00	0.00			28	--	--	--	--	--	
29									0.00	--	30	--	--	1	SPACE	--	
TOTAL LOAD:						0.18 kVA		0.00 kVA		0.00 kVA							
BREAKER TYPE KEYS:																	
LO - INDICATES C.B. EQUIPPED WITH "LOCK-ON" DEVICE																	
GF - INDICATES C.B. IS GROUND FAULT TYPE (5mA FOR PERSONNEL)																	
ST - INDICATES C.B. EQUIPPED WITH SHUNT TRIP DEVICE																	
HT - INDICATES C.B. EQUIPPED WITH 30mA GROUND FAULT FOR EQUIPMENT																	
Load Classification	Connected Load					Demand Factor			Estimated Demand			Panel Totals					
Equipment	0.18					100.00%			0.18								
Total Conn. Load: 0.18 kVA																	
Total Est. Demand: 0.18 kVA																	
Total Conn. Current: 0.50 A																	
Total Est. Demand Current: 0.50 A																	

REV	DESCRIPTION	DATE
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REVISIONS

SUBMISSION TITLE:
OSE DOCUMENTS

SEAL:



DRAWN BY: BWT DATE: 12/11/2023
DESIGNED BY: BWT SCALE: 1/8" = 1'-0"
CHECKED BY: DMS RMF JOB NO.: 03230577.A0
PROJ. MGR.: DMS OSE JOB #: H59-N260-LC

PROJECT NAME:
ATC - 300 Chiller Replacement

PROJECT ADDRESS:
2276 Jefferson Davis Hwy,
Graniteville, SC 29829

DRAWING TITLE:
ELECTRICAL SCHEDULES

DRAWING NUMBER:
E-201

